

NATIONAL SENIOR CERTIFICATE

GRADE 12

ENGINEERING GRAPHICS AND DESIGN P1 NOVEMBER 2008

MARKS: 100

TIME: 3 hours

This question paper consists of 6 pages.

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INSTRUCTIONS AND INFORMATION

- 1. The question paper consists of FOUR questions.
- 2. Answer ALL the questions.
- 3. All drawings are in first-angle orthographic projection unless otherwise stated.
- 4. All drawings must be drawn to scale 1:1, unless otherwise stated.
- 5. The questions must be answered on the answer sheets provided.
- 6. All the answer sheets must be re-stapled in numerical sequence and handed in irrespective of whether the question was attempted or not.
- 7. Time management is essential in order to complete all the questions.
- 8. Print your examination number in the block provided on every answer sheet.
- 9. All answers must be drawn accurately and neatly.
- 10. Any details or dimensions not given must be assumed in good proportion.

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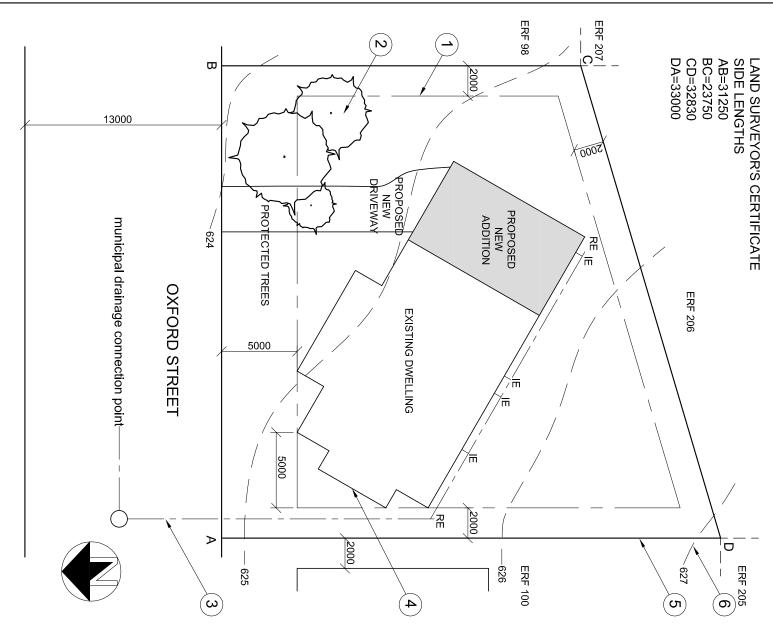
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THE SITE PLAN SHOWS ERF 99 SITUATED IN EAST LONDON

SURVEYED ON 25-09-2008



QUESTION 1: ANALYTICAL (CIVIL)

Given:A table of questions and a site plan of a proposed new addition to an existing dwelling.

Instructions:

Complete the table below by neatly printing the answers to the questions, which all refer to the accompanying drawing.

[25]

25	TOTAL 25		
ω		Determine the total area of the erf in m².	20 [
ω		Determine the perimeter of the erf in metres.	19 [
N		The side of the new addition that faces Oxford Street will be called theelevation.	18
Ν		The municipality rejected the plan because of the driveway. Why?	17 7
Ν		What is the height difference between corner B and corner D on the erf?	16 \
_		What is the feature at 6 called?	15 \
_		What is the feature at 5 called?	14 \
_		What is the feature at 4 called?	13 \
_		What is the feature at 3 called?	12 \
		What is the feature at 2 called?	11 \
_		What is the feature at 1 called?	10 \
_		How many inspection eyes are there?	9
_		What is the distance from the municipal boundry line on Oxford Street to the front building line of the property?	∞ =. <
_		In which South African city would you find this property?	7
_		What SI unit is used for the dimensions?	6
_		What is the total length of the front of the erf in metres?	5 \
1/2		On what date was the site surveyed?	4 (
1/2		What is the scale of the drawing?	3
1/2		What is the erf number of the site?	2 \
1/2		What type of drawing is shown?	_
	ANSWERS	QUESTIONS	

EXAMINATION NUMBER

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SCALE 1:200

QUESTION 2: DEVELOPMENT


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Given:The front view and top view of a rectangle-to-round transition piece.

- Instructions:
 Draw the given views of the transition piece.
 Develop the surface of the transition piece.
 Show ALL necessary construction and fold lines.

60

[35]

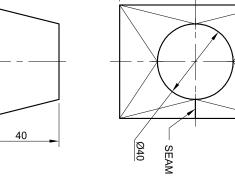

80



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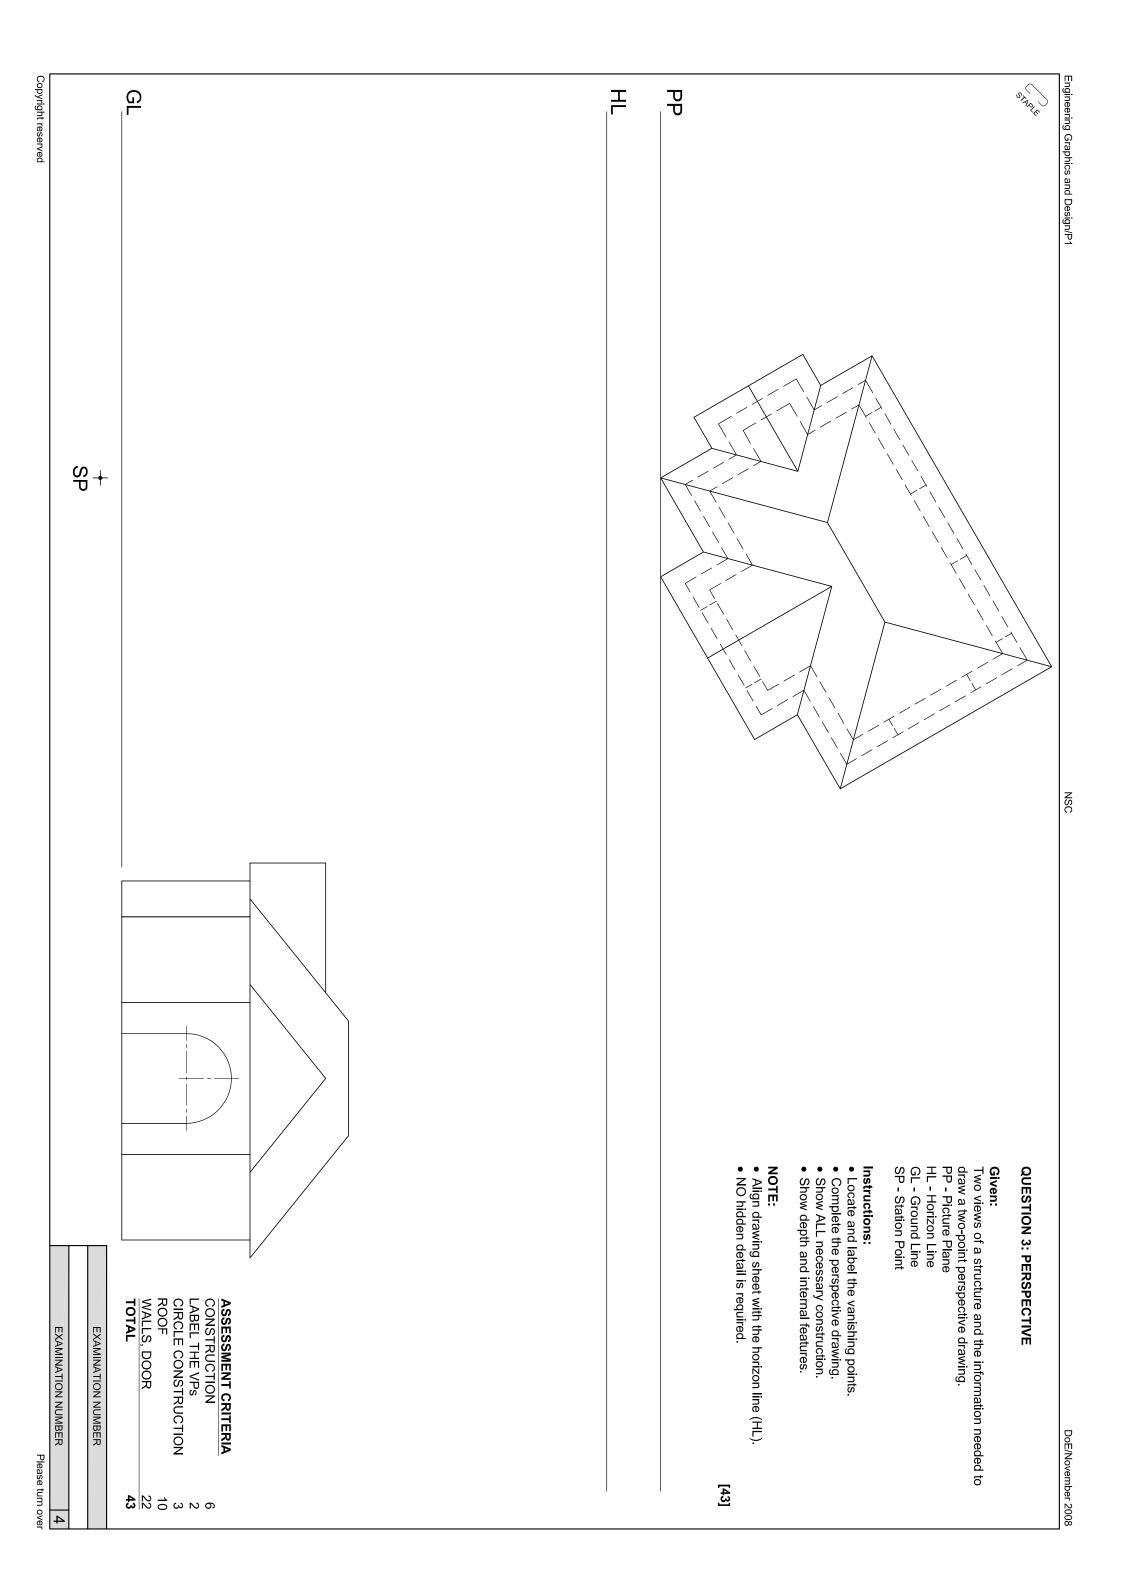
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ASSESSMENT CRITERIA
FRONT VIEW
TOP VIEW
CENTRE LINES
TOP VIEW DIVISIONS
TRUE LENGTH x4
DEVELOPMENT
TOTAL
25



Engineering Graphics and Design/P1 NSC DoE/November 2008



WINDOW SCHEDULE DOOR AND

ROOF PITCH 30°

RIDGE CAP

(15))

ROOF NOTES: ROOF COVER: 18 mm RCP ON 75 x 38 PURLINS @ 800 C/C

PROPOSED NEW TV ROOM ON ERF 329 EAST LONDON

DRAWING NUMBER DOE 2-08

7 SIDE ROAD EAST LONDON 043 708 5555 **DOOR DEN**

FRAME PROFILE 50 32

230

GLAZING 3 mm CLEAR GLASS


DOOR FRAME STANDARD, EXTERNAL, MILD STEEL

WINDOW STANDARD, MILD STEEL, ND 511

DOOR H/W FRAMED, LEDGED AND BATTENED

TWO-LEVER LOCKSET RONMONGERY
PAIR 75 mm BOLTS,

1540 500 HINGED SIDE 2000

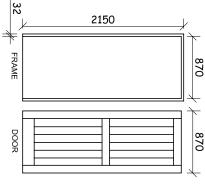

SR X

2 X 40 W


SOCKET OUTLET

D₅

D-

or X

ELECTRICAL LEGEND

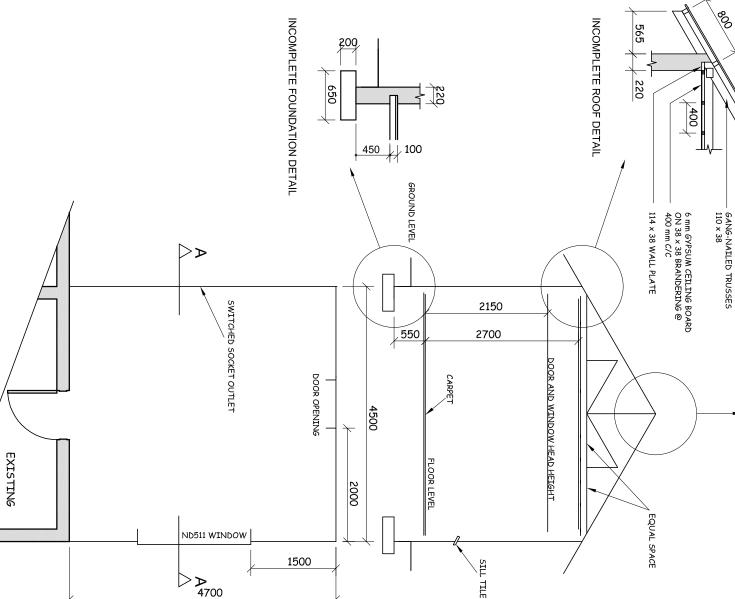

QUESTION 4: CIVIL DRAWING

Given:

- A schematic floor plan and schematic sectional elevation of the outer perimeter of a proposed new TV room to an existing dwelling, and the position of all the features.
- A door and incomplete window schedule.
- Sketches of the roof and incomplete foundation detail.
- An electrical legend.

Instructions:

- Answer this question on ANSWER SHEET 4 on page 6.
- Draw, Attach the drawing of the *proposed new TV room* to to scale 1:50, the complete floor plan and
- the given information on ANSWER SHEET 4.

SPECIFICATIONS: THE FLOOR PLAN Add the following features to the floor plan:

- the walls with hatching detail
- ALL the walls with hatching detail
 The door and the window detail
 ONE light outside the room and n
 ONE light in the centre of the ceili new TV room light in the centre of the ceiling of the proposed light outside the room and near to the door and
- A separate switch for each lightONE switched socket outlet in the middle of the indicated ¥a
- The cutting plane. Label the plane A-A
- Label the floor plan and include the scale

A SECTIONAL ELEVATION

Add the following features to the sectional elevation:

- The complete foundation, wall, floor slab and roof detailThe door and complete window detail
- ALL r ecessary hatching
- Label A-V the sectional elevation: SECTIONAL ELEVATION

NOTE

- Label ONLY the following features and on the correct view: natural ground level, damp proof course, propos designation and floor finish. natural ground level, damp proof course, proposed
- room ALL s substructure hatching may be done in freehand.
- in the drawing must comply with the guidelines contained SABS 0143.

[97]

TERMINOLOGY

Schematic diagram: a diagram that shows the main features or relationships but not the details.

SCHEMATIC SECTIONAL ELEVATION

SCHEMATIC PLAN

5

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NSC

Engineering Graphics and Design/P1

ASSESSMENT CRITERIA

POSSIBLE	ТОТ
OBTAINED	FOTAL

\		FLOOR PLAN	
	5	LAN	

FLOOR FLAN	LAIN	
1 OUTLINE	5	
2 WINDOW & DOOR	7	
3 HATCHING	3	
4 LIGHTS & SWITCH & SOCKET OUTLET	8	
5 LABELS & CUTTING PLANE	8	
6 JOIN	_	

	S & CUTTING	S & SWITCH &	HING	DW & DOOR	Zm	
1	8	œ	3	7	5	!

11 ROOF TRUSS, CAP, GANGNAILS & COVER 12 CEILING, PURLINS & BRANDERING

12

Ŋ

17

TOTAL 97

8 HATCHING

ယ 9

10 WINDOW

7 FOUNDATION, SLAB & WALL

12

SECTIONAL ELEVATION

INE 5	5
OW & DOOR	7
HING	3
TS & SWITCH & T OUTLET	8
LS & CUTTING	8
\	`

FLOOR PLAN	LAN
E	5
N & DOOR	7
NG	3
& SWITCH &	∞

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EXISTING

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